


MARK	DATE	DESCRIPTION
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PROJECT NO: 2012.017.00
MODEL FILE: 2012.017.00
DRAWN BY: TF
CHK'D BY: RD
DATE: xx/xx/2012
CPY

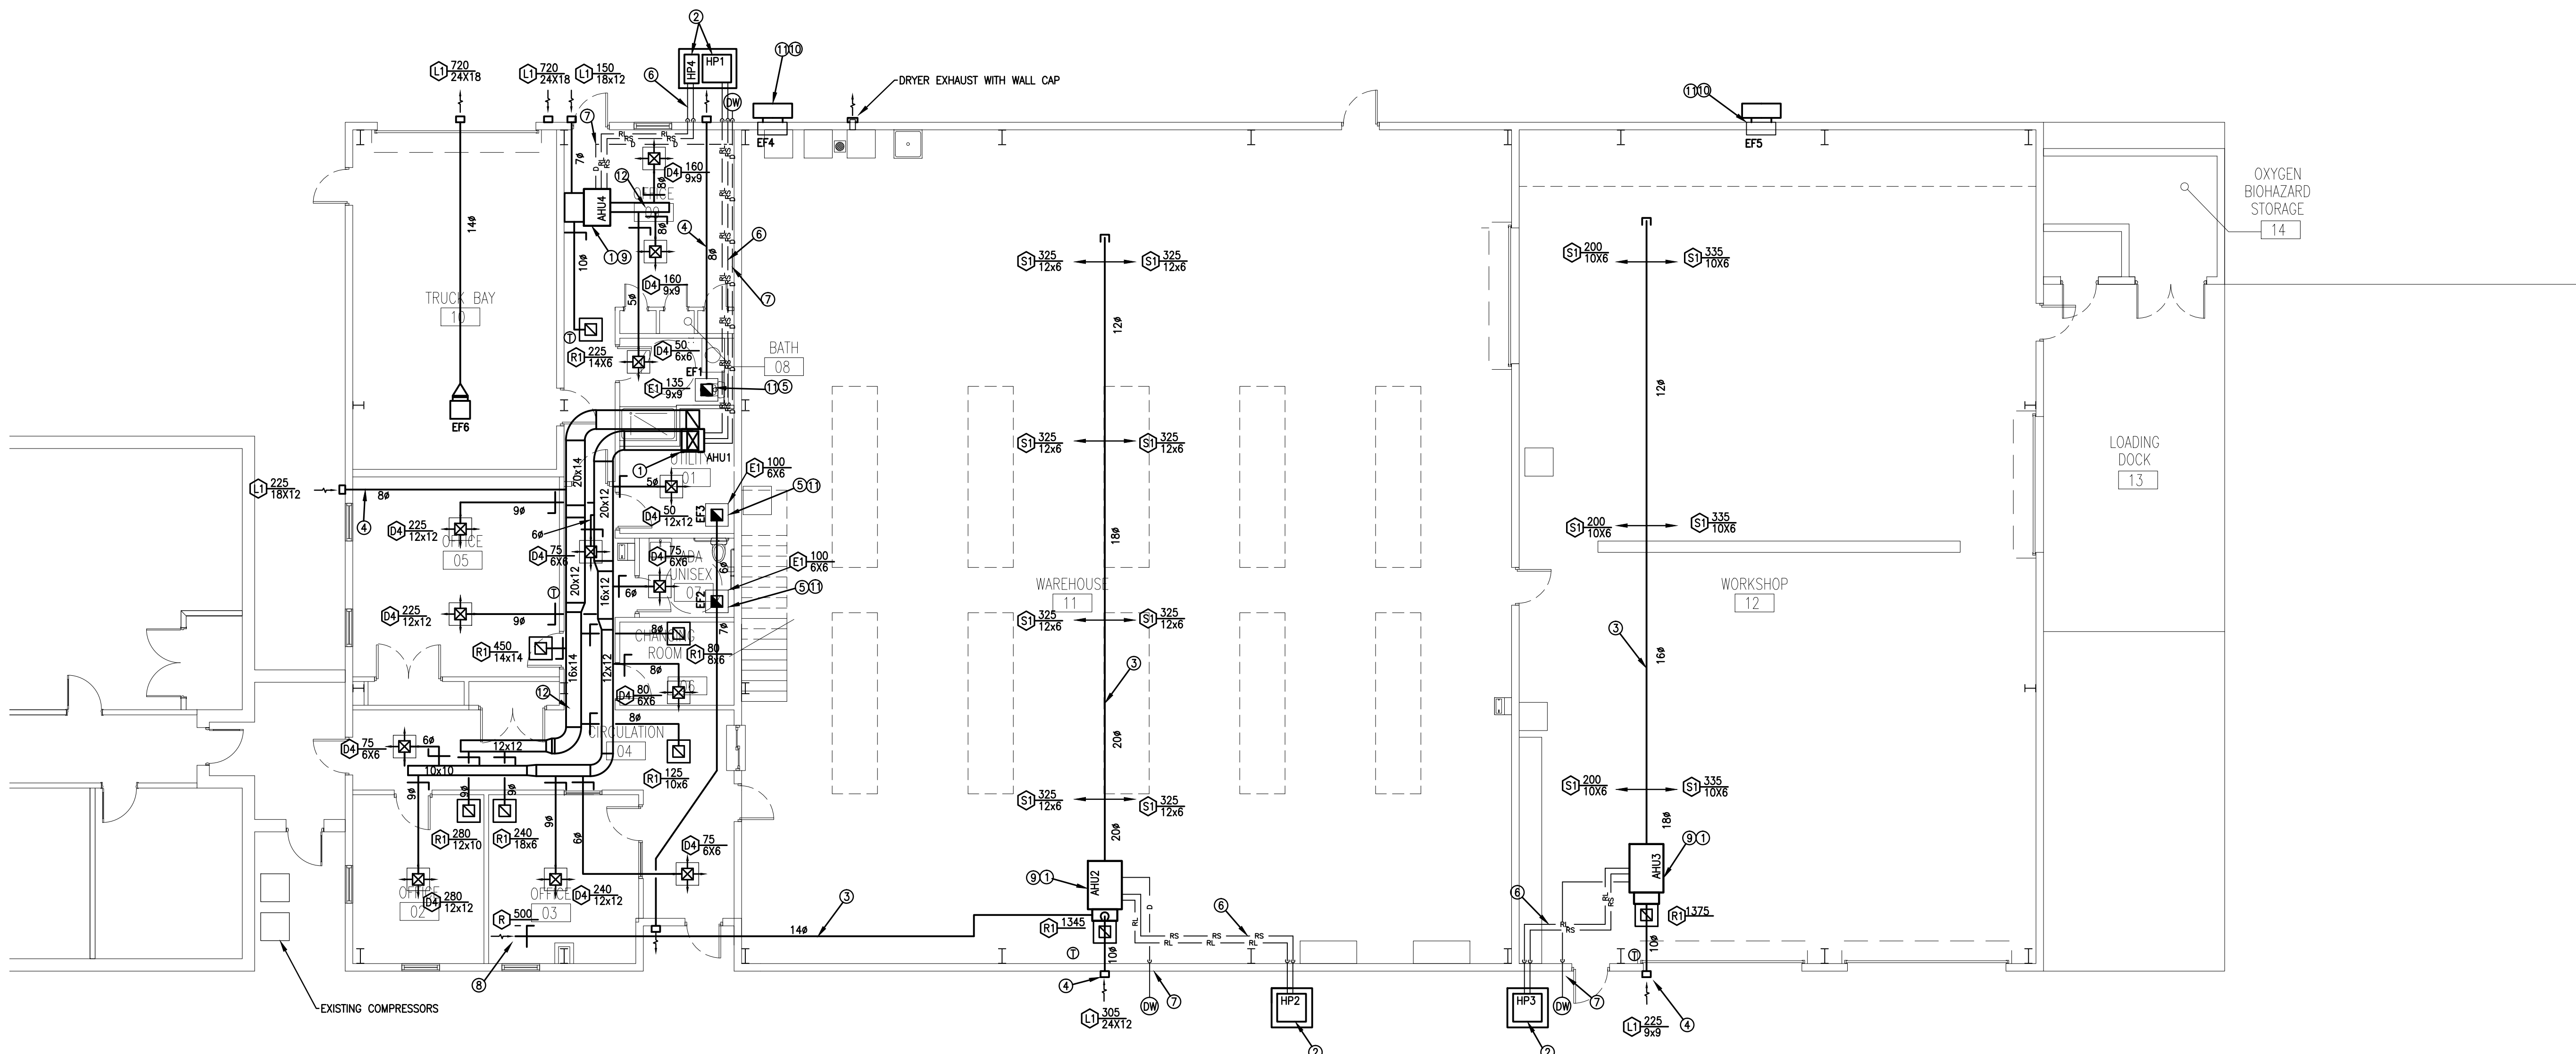

NEW WORK NOTE SCHEDULE

- 1 PROVIDE SPLIT SYSTEM AIR HEAT PUMP HANDLER & ASSOCIATED DUCTWORK, INSULATION, CONTROLS, AIR DEVICES & SUPPORTS.
- 2 PROVIDE OUTDOOR HEAT PUMP UNIT ON 6" THICK REINFORCED CONCRETE PAD. PAD TO EXTEND A MINIMUM OF 6" BEYOND UNIT FOOTPRINT.
- 3 RUN DUCT WORK EXPOSED APPROXIMATELY 15 FEET AFF.
- 4 PROVIDE OUTSIDE AIR DUCTWORK TO LOUVER. INCLUDE WALL LOUVER WITH BIRD SCREEN. SEE SCHEDULE DWG M2.0
- 5 PROVIDE CABINET EXHAUST FAN IN CEILING. PROVIDE EXHAUST DUCT TO EXTERIOR RECTANGULAR HOODED WALL CAP.
- 6 REFRIGERATION LINES FROM HEAT PUMP TO AIR HANDLER. RUN LINES CONCEALED. SEE DETAIL ON SHEET M3.0.
- 7 INSULATED CONDENSATE PIPE IN WALL TO DRYWELL. SEE DETAIL ON SHEET M3.0. CONTRACTOR TO COORDINATE ROUTING OF CONDENSATE PIPING PRIOR TO SETTING EQUIPMENT.
- 8 TERMINATE RETURN DUCT IN MEZZANINE SPACE WITH OPEN END.
- 9 SUSPEND AIR HANDLER FROM STRUCTURE. SEE DETAIL DWG M3.0.
- 10 PROVIDE SIDE WALL EXHAUST FAN. SEE DETAIL DWG M3.0.
- 11 INTERLOCK EXHAUST FAN WITH AIR HANDLER TO POWER ON WHEN AIR HANDLER IS IN USE.
- 12 DUCT WORK FOR AHU1 AND AHU4 SHALL BE RUN ABOVE SUSPENDED CEILING, UNO.

1 MECHANICAL PLAN
M1.0 SCALE: 1/8" = 1'-0"

